

NOTE: SURVEY PLAN PROVIDED FOR REFERENCE ONLY



BLOCK 8

NOT FOR CONSTRUCTION

This drawing supercedes previous issues. Do not scale these drawings.

Verify all dimensions, elevations and datums, and report any discrepancies to the Architect prior to construction. Dimensions are taken to face of exterior sheathing, face of concrete block, face of stud for interior partitions, and centreline of demising walls, unless noted otherwise on the drawing.

All drawings remain the property of the Architect. These drawings are Copyright 2013, S2 Architecture. These drawings may not be reproduced without the permission of the Architect.

REVISIONS DAT

ISSUED FOR DP DEC 10, 2018

SCALE AS NOTED


DATE December 7, 2018

DRAWN BY AG

CHECKED BY MR

DRAWING NO.

DP0.02

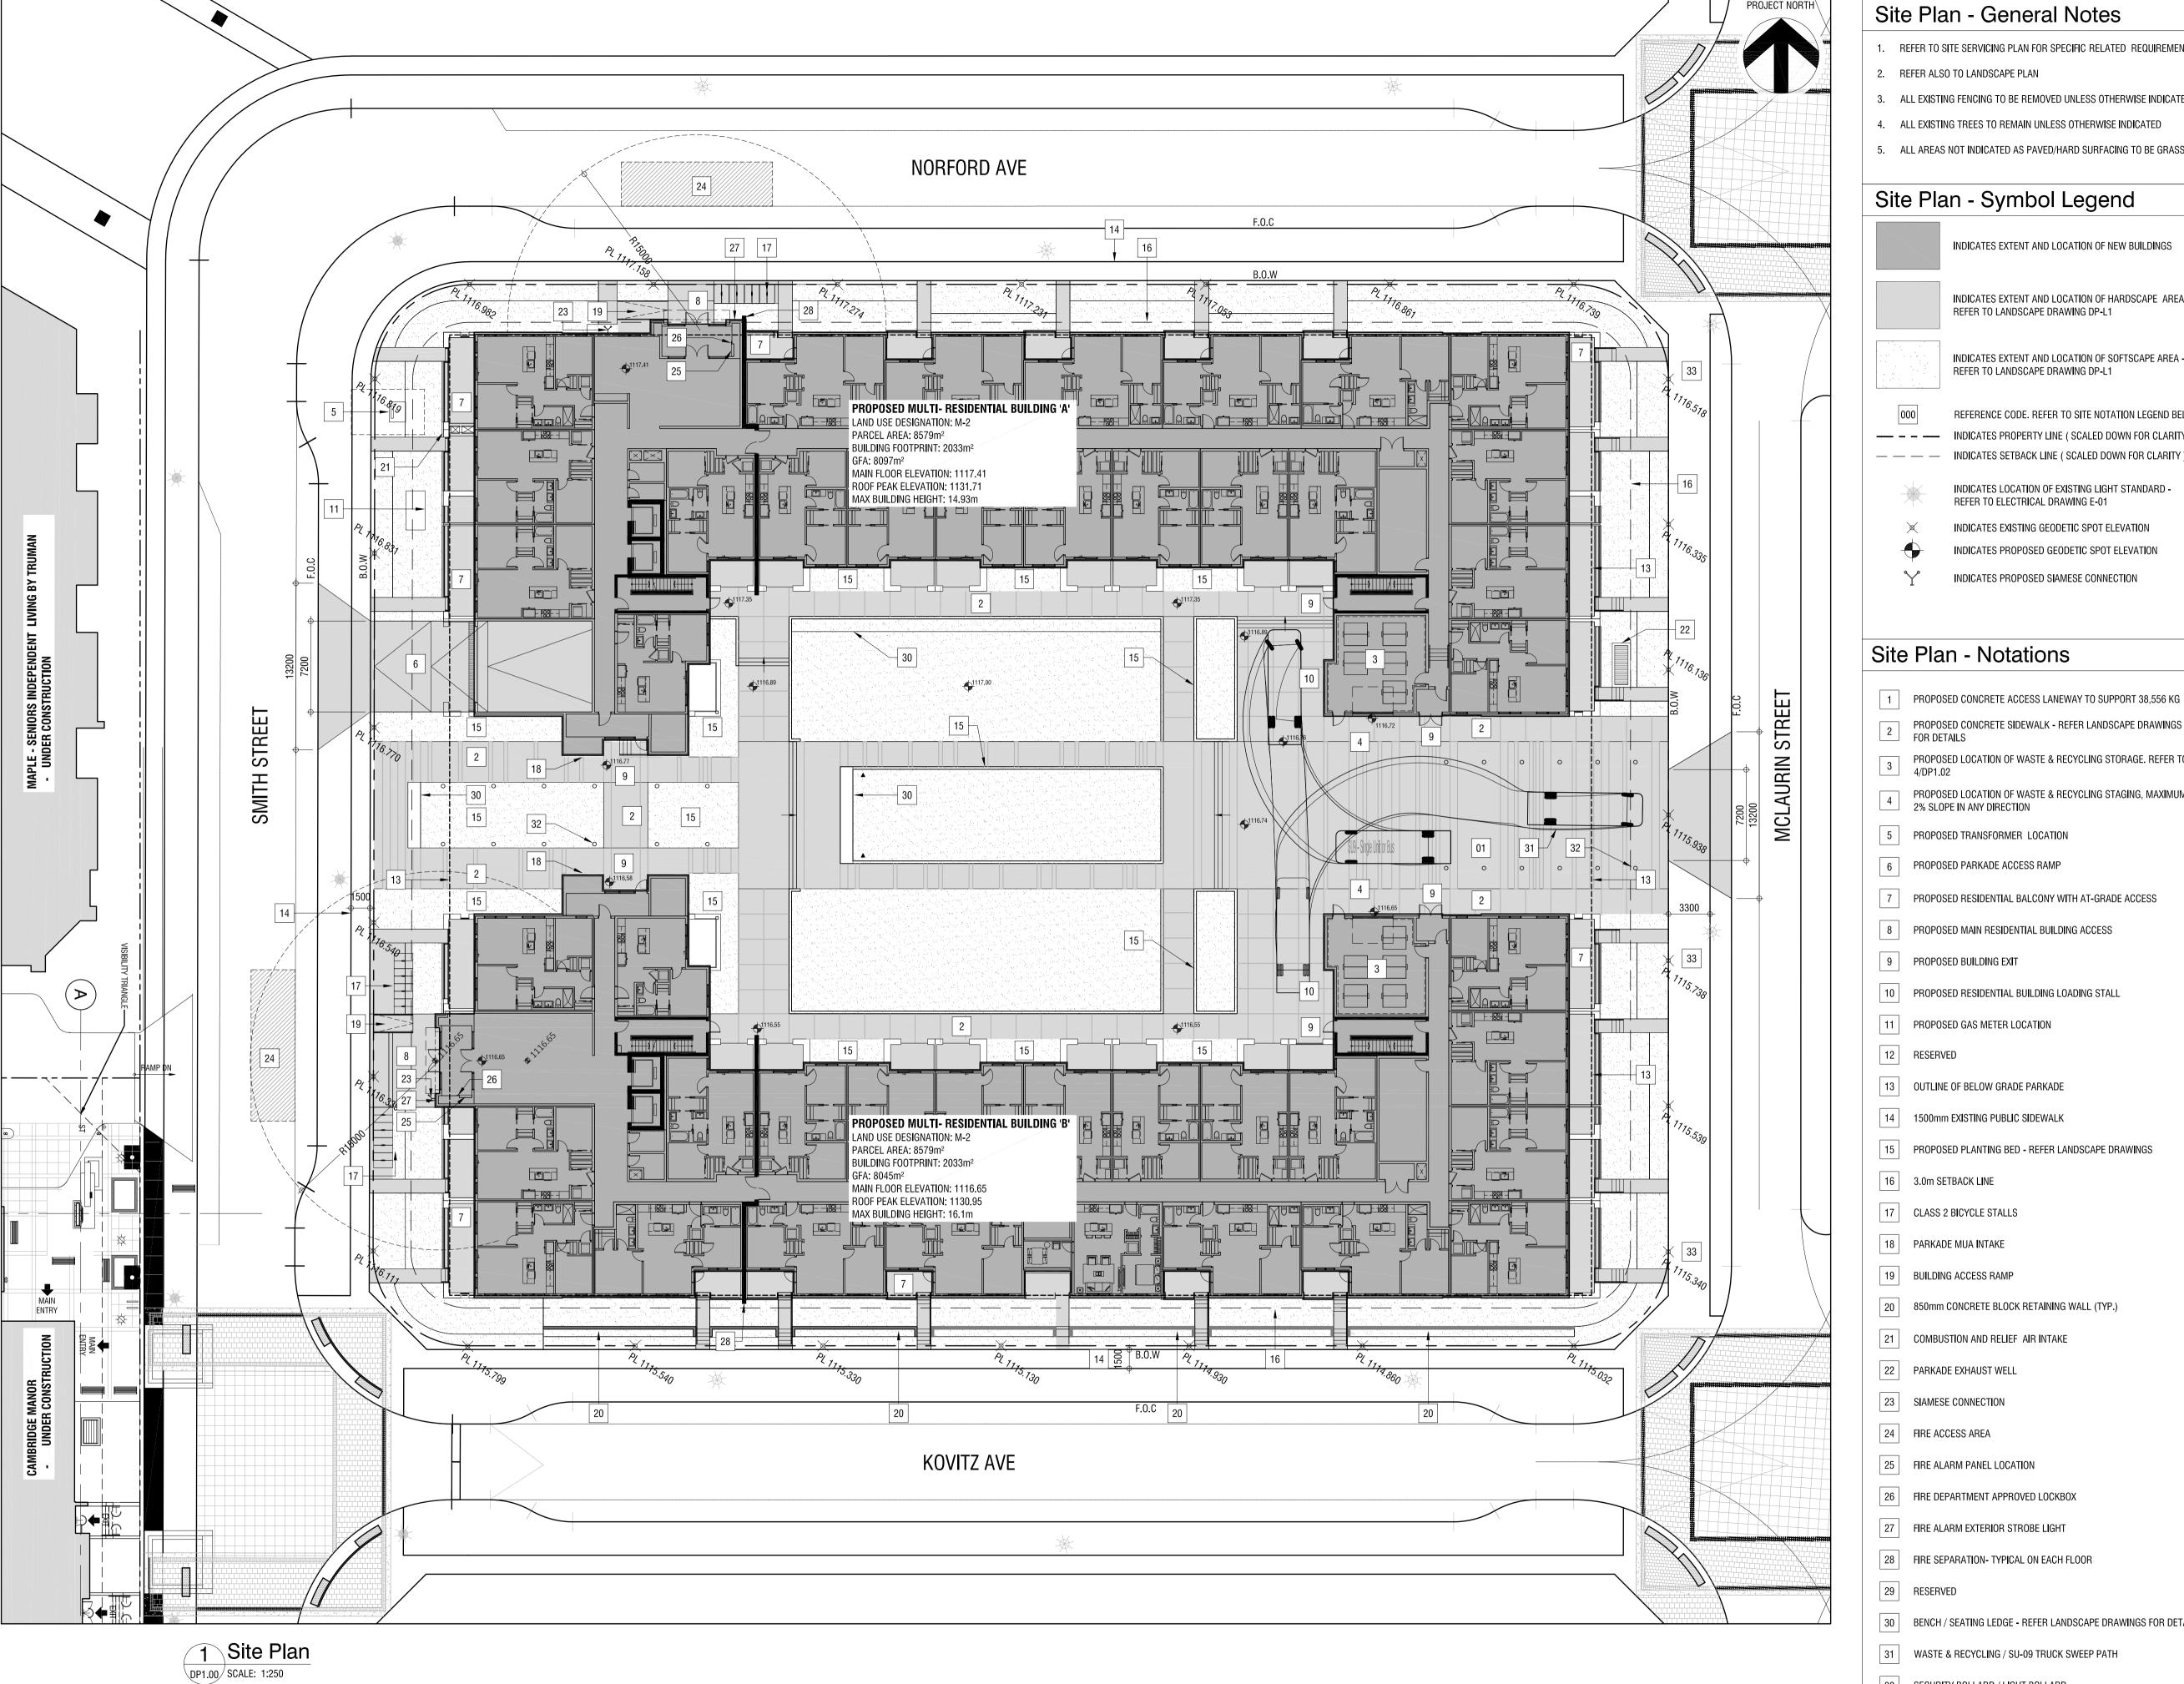

Site Plan - General Notes

- 1. REFER TO SITE SERVICING PLAN FOR SPECIFIC RELATED REQUIREMENTS
- 2. REFER ALSO TO LANDSCAPE PLAN
- 3. ALL EXISTING FENCING TO BE REMOVED UNLESS OTHERWISE INDICATED
- 4. ALL EXISTING TREES TO REMAIN UNLESS OTHERWISE INDICATED
- 5. ALL AREAS NOT INDICATED AS PAVED/HARD SURFACING TO BE GRASSED

Site Plan - Symbol Legend

INDICATES EXTENT AND LOCATION OF NEW BUILDINGS

INDICATES EXTENT AND LOCATION OF HARDSCAPE AREA -REFER TO LANDSCAPE DRAWING DP-L1

INDICATES EXTENT AND LOCATION OF SOFTSCAPE AREA -REFER TO LANDSCAPE DRAWING DP-L1

REFERENCE CODE. REFER TO SITE NOTATION LEGEND BELOW INDICATES PROPERTY LINE (SCALED DOWN FOR CLARITY) INDICATES SETBACK LINE (SCALED DOWN FOR CLARITY)

INDICATES LOCATION OF EXISTING LIGHT STANDARD -REFER TO ELECTRICAL DRAWING E-01

INDICATES EXISTING GEODETIC SPOT ELEVATION INDICATES PROPOSED GEODETIC SPOT ELEVATION

INDICATES PROPOSED SIAMESE CONNECTION

Site Plan - Notations

- PROPOSED CONCRETE SIDEWALK REFER LANDSCAPE DRAWINGS FOR DETAILS
- PROPOSED LOCATION OF WASTE & RECYCLING STORAGE. REFER TO
- PROPOSED LOCATION OF WASTE & RECYCLING STAGING, MAXIMUM 2% SLOPE IN ANY DIRECTION

- 8 PROPOSED MAIN RESIDENTIAL BUILDING ACCESS
- 10 PROPOSED RESIDENTIAL BUILDING LOADING STALL
- 11 PROPOSED GAS METER LOCATION
- 13 OUTLINE OF BELOW GRADE PARKADE
- 15 PROPOSED PLANTING BED REFER LANDSCAPE DRAWINGS
- 17 CLASS 2 BICYCLE STALLS


- 20 850mm CONCRETE BLOCK RETAINING WALL (TYP.)
- 21 COMBUSTION AND RELIEF AIR INTAKE

- 26 FIRE DEPARTMENT APPROVED LOCKBOX
- 27 FIRE ALARM EXTERIOR STROBE LIGHT
- 28 FIRE SEPARATION- TYPICAL ON EACH FLOOR
- 30 BENCH / SEATING LEDGE REFER LANDSCAPE DRAWINGS FOR DETAILS
- 31 WASTE & RECYCLING / SU-09 TRUCK SWEEP PATH
- 32 SECURITY BOLLARD / LIGHT BOLLARD
- 33 3300mm EXISTING PUBLIC SIDEWALK



 ∞

SITE PLAN

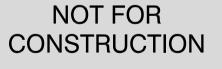

This drawing supercedes previous issues. Do not scale these

Verify all dimensions, elevations and datums, and report any discrepancies to the Architect prior to construction. Dimensions are taken to face of exterior sheathing, face of concrete block, face of stud for interior partitions, and centreline of demising walls, unless noted otherwise on the drawing.

All drawings remain the property of the Architect. These drawings are Copyright 2013, S2 Architecture. These drawings may not be reproduced without the permission of the Architect.

REVISIONS

1\ ISSUED FOR DP

SCALE AS NOTED December 10, 2018 DRAWN BY AG CHECKED BY MR

DRAWING NO.

DP1.00

DEC 10, 2018